



**PLAN**  
SCALE: 1" = 100'

**LEGEND**  
ad-09-1106 BORE HOLE LOCATION

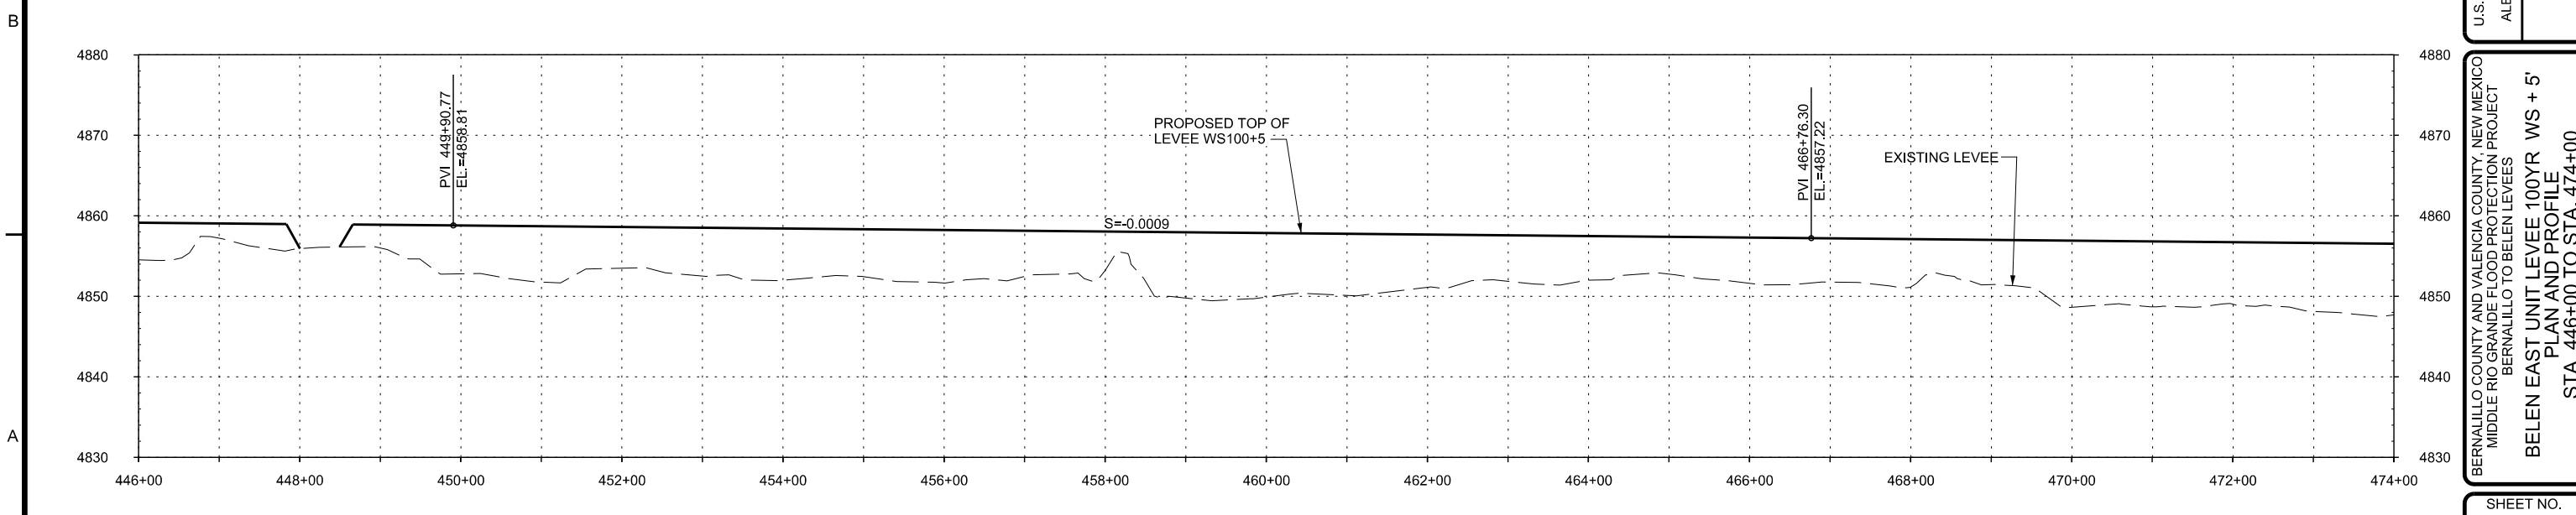

**PROFILE**  
SCALE: HORIZ: 1" = 100'  
VERT: 1"=10'

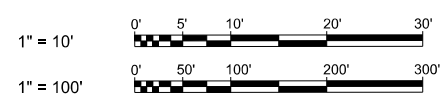

US Army Corps  
of Engineers  
Albuquerque District

Mark	Description	Date	Appr.

File Name: g:\38600\1106gn  
Plot Scale: 100:1  
Plot Date: AUGUST 2015  
SOL/CONTRACT NO.:  
PROJECT NO.:  
ero Accidents  
ero Tolerance


DESIGN BY:  
SEE COVER  
DRAWN BY:  
SEE COVER  
REVIEWED BY:  
SEE COVER

U.S. ARMY ENGINEER DISTRICT  
CORPS OF ENGINEERS  
ALBUQUERQUE, NEW MEXICO

BERNALILLO COUNTY AND VALENCIA COUNTY, NEW MEXICO  
MIDDLE RIO GRANDE FLOOD PROTECTION PROJECT  
BERNALILLO TO BELEN LEVEES  
BELEN EAST UNIT LEVEE 100YR WS + 5'  
PLAN AND PROFILE  
STA. 446+00 TO STA. 474+00

SHEET NO.  
**C-118**  
21 OF 39


SEQUENCE NO.  
**36**

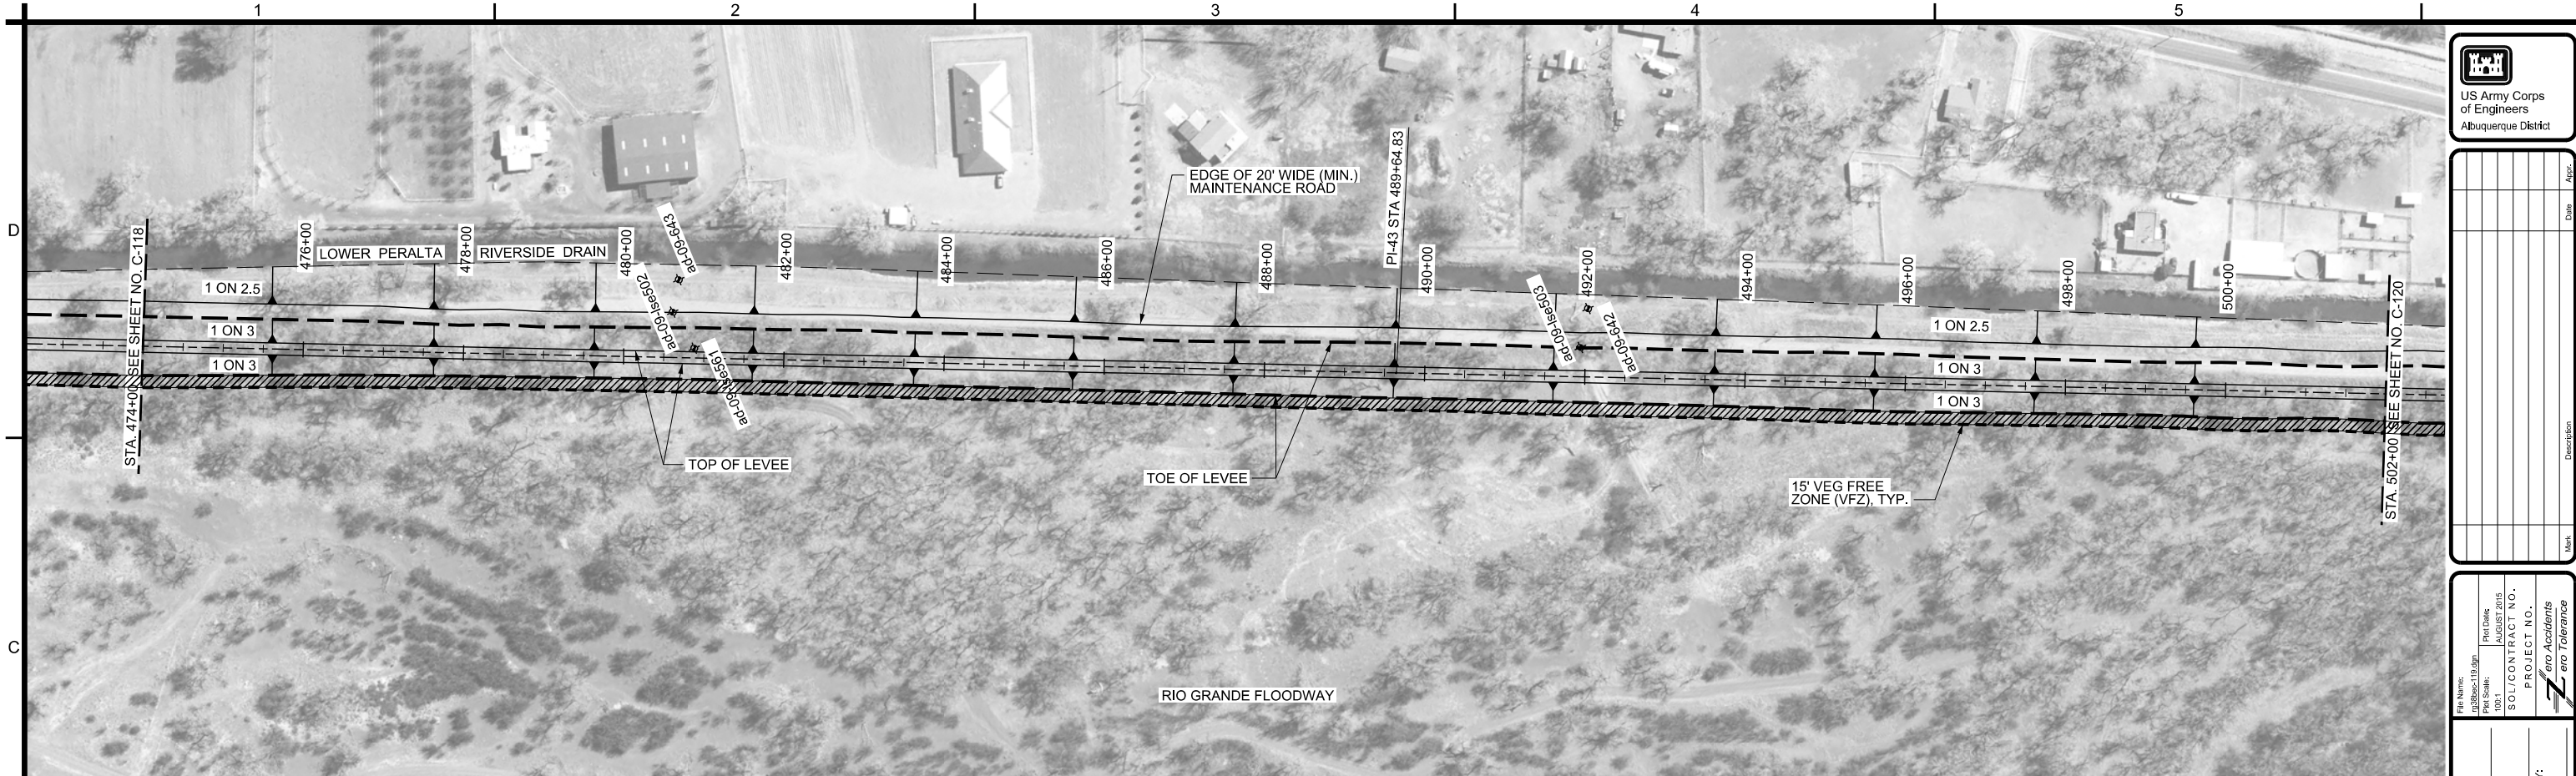


**PLAN**  
SCALE: 1" = 100'

**LEGEND**

ad-09-1106 BORE HOLE LOCATION

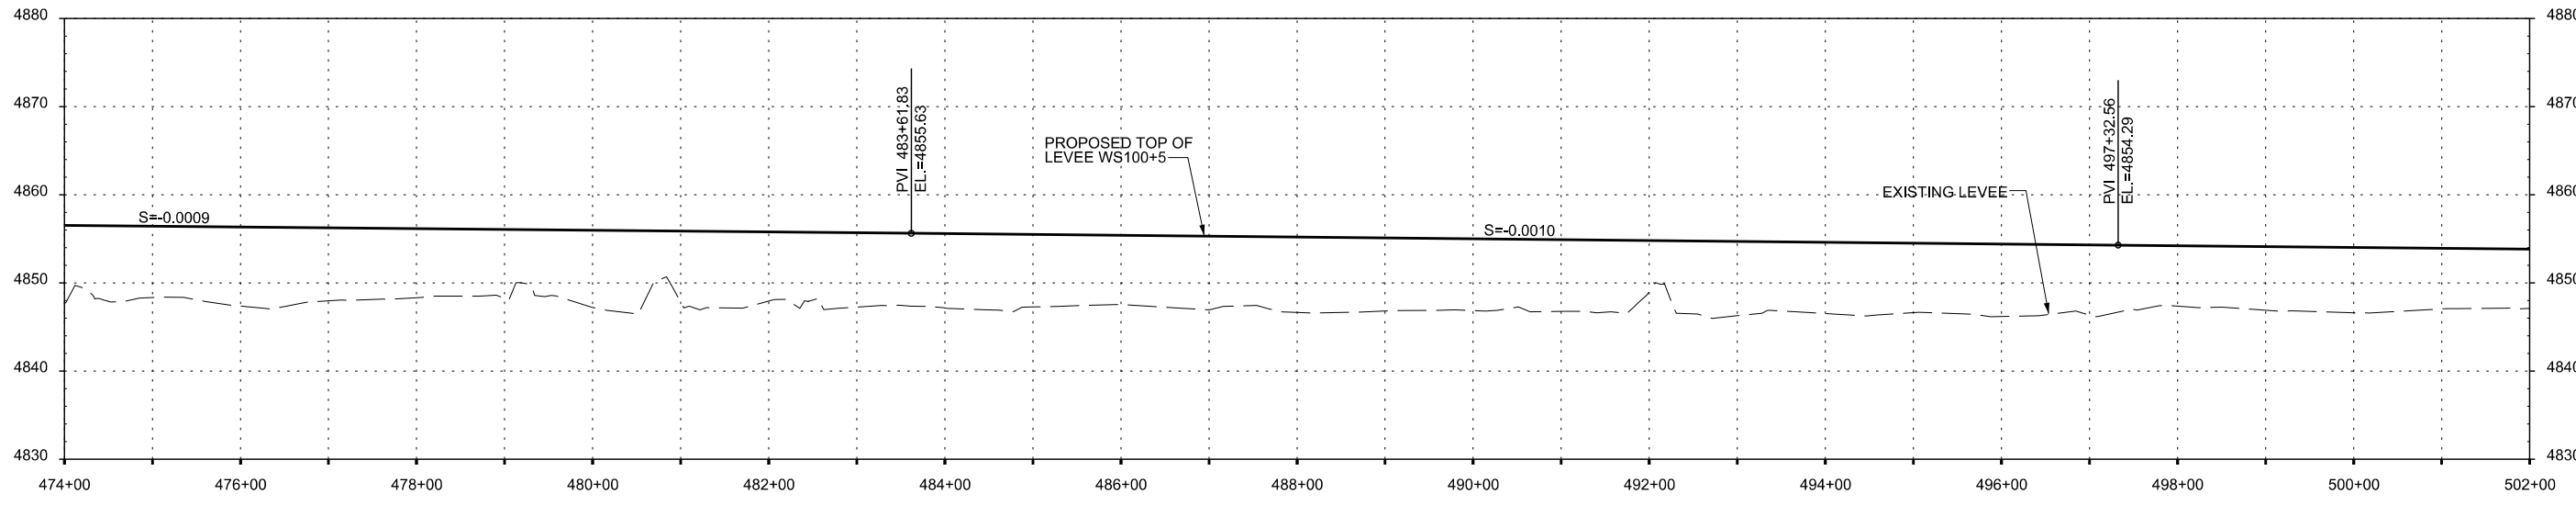

**PROFILE**  
SCALE: HORIZ: 1" = 100'  
VERT: 1"=10'

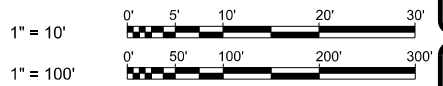

Mark	Describe	Date	Appr.

File Name: ad-09-1106.dgn	Plot Date: AUGUST 2015
Plot Scale: 100:1	SOL/CONTRACT NO.: PROJECT NO.



DESIGN BY: SEE COVER	
DRAWN BY: SEE COVER	
REVIEWED BY: SEE COVER	

U.S. ARMY ENGINEER DISTRICT  
CORPS OF ENGINEERS  
ALBUQUERQUE, NEW MEXICO

BERNALILLO COUNTY AND VALENCIA COUNTY, NEW MEXICO  
MIDDLE RIO GRANDE FLOOD PROTECTION PROJECT  
BERNALILLO TO BELEN LEVEES  
BELEN EAST UNIT LEVEE 100YR WS + 5'  
PLAN AND PROFILE  
STA. 474+00 TO STA. 502+00

SHEET NO.  
**C-119**  
22 OF 39  
SEQUENCE NO.  
**37**




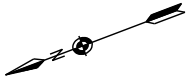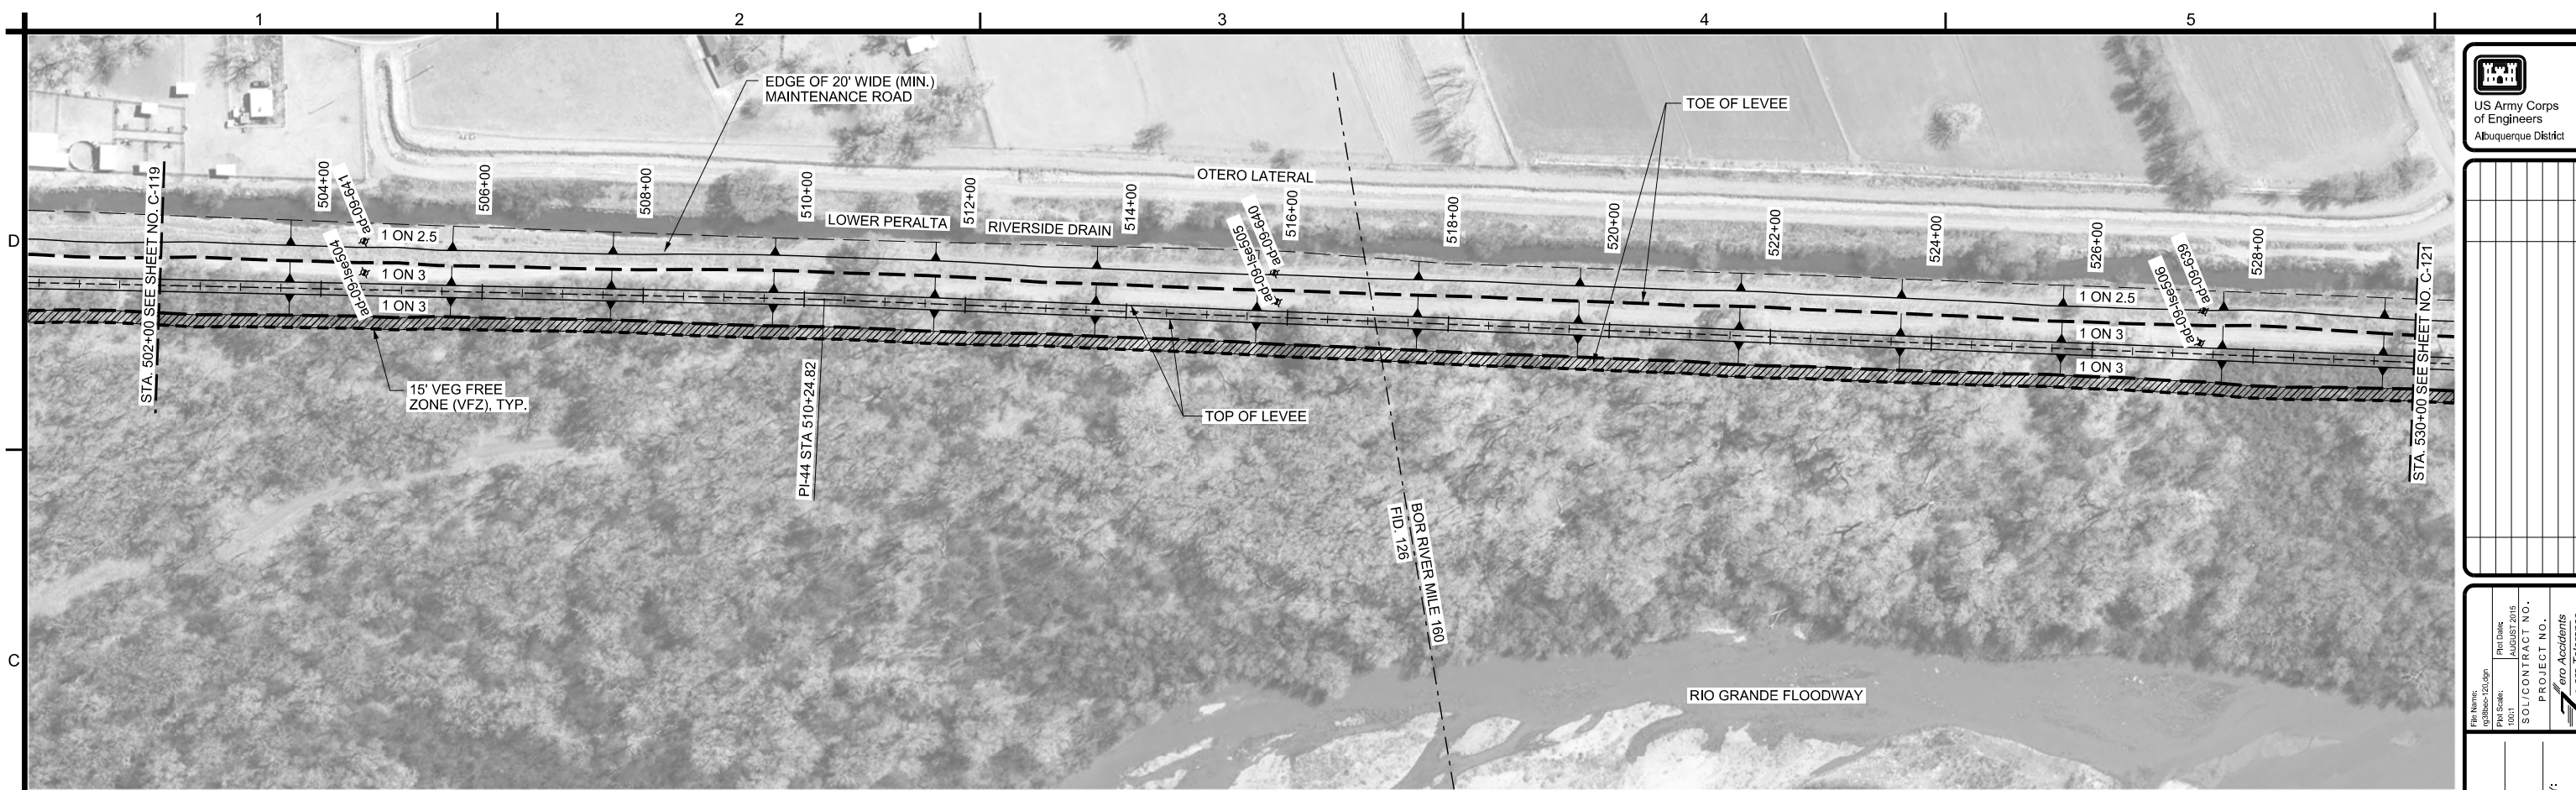


**PLAN**  
SCALE: 1" = 100'

**LEGEND**

ad-09-1106 BORE HOLE LOCATION

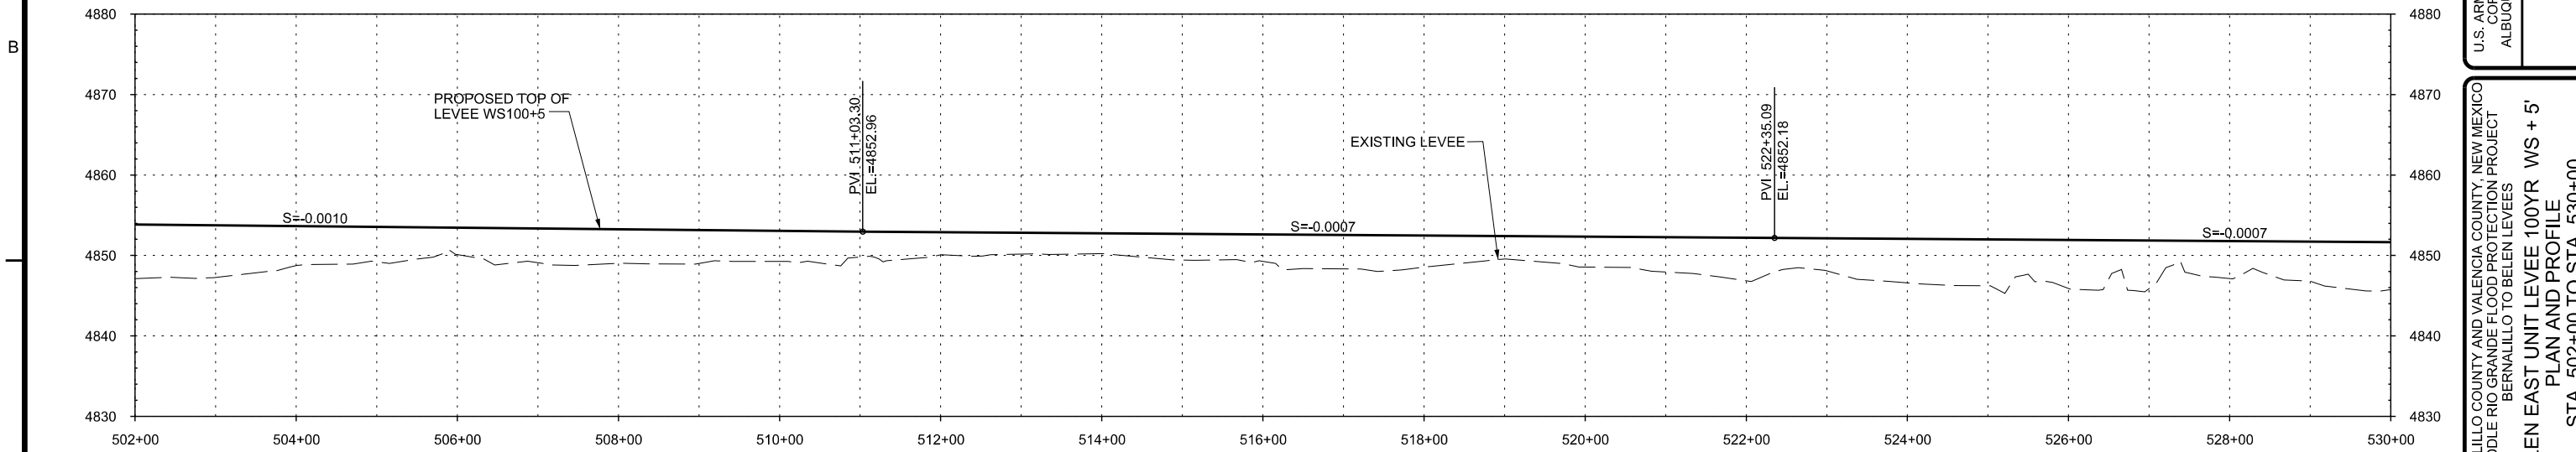

**PROFILE**  
SCALE: HORIZ: 1" = 100'  
VERT: 1"=10'

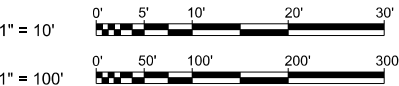

Mark	Description	Date	Appr.


File Name: ad-09-1106.dgn	Proj Date: AUGUST 2015
Proj Scale: 100:1	SOL/CONTRACT NO.: PROJECT NO.

DESIGN BY: SEE COVER	
DRAWN BY: SEE COVER	
REVIEWED BY: SEE COVER	

U.S. ARMY ENGINEER DISTRICT  
CORPS OF ENGINEERS  
ALBUQUERQUE, NEW MEXICO

BERNALILLO COUNTY AND VALENCIA COUNTY, NEW MEXICO  
MIDDLE RIO GRANDE FLOOD PROTECTION PROJECT  
BERNALILLO TO BELEN LEVEES  
BELEN EAST UNIT LEVEE 100YR WS + 5'  
PLAN AND PROFILE  
STA. 502+00 TO STA. 530+00


SHEET NO.  
**C-120**  
23 OF 39  
SEQUENCE NO.  
**38**

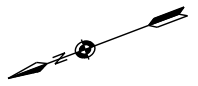


**PLAN**  
SCALE: 1" = 100'

**LEGEND**

ad-09-1106 BORE HOLE LOCATION

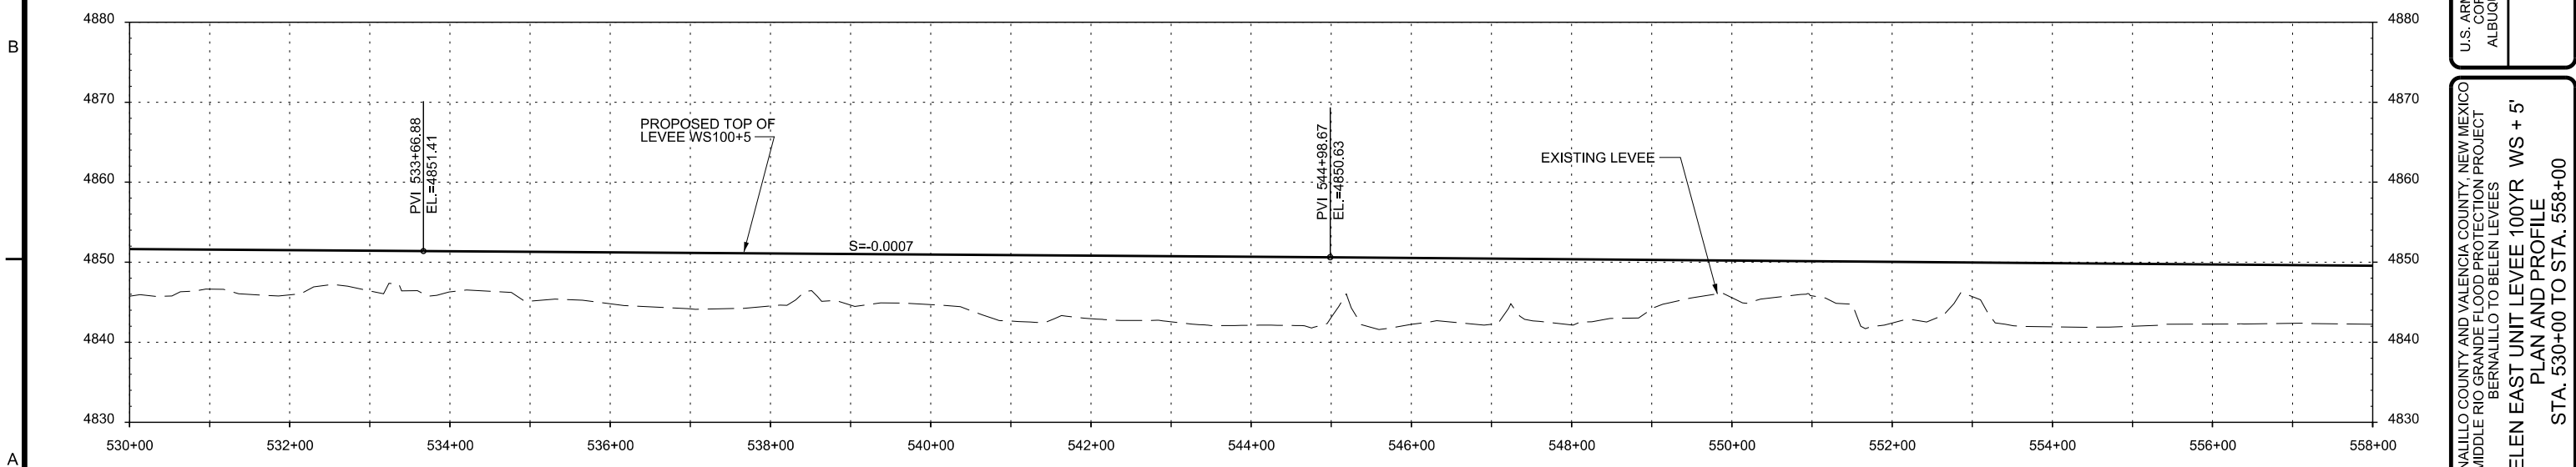

**PROFILE**  
SCALE: HORIZ: 1" = 100'  
VERT: 1"=10'

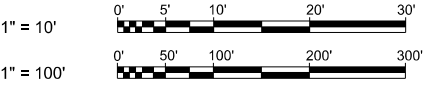

Mark	Description	Date	Appr.

File Name: g:\Bernalillo\21.dgn	Proj Date: AUGUST 2015
Plot Scale: 1/8"=1'	SOL/CONTRACT NO.:
	PROJECT NO.:
	ero Accidents
	ero Tolerance


DESIGN BY: SEE COVER	
DRAWN BY: SEE COVER	
REVIEWED BY: SEE COVER	

U.S. ARMY ENGINEER DISTRICT  
CORPS OF ENGINEERS  
ALBUQUERQUE, NEW MEXICO


BERNALILLO COUNTY AND VALENCIA COUNTY, NEW MEXICO  
MIDDLE RIO GRANDE FLOOD PROTECTION PROJECT  
BERNALILLO TO BELEN LEVEES  
BELEN EAST UNIT LEVEE 100YR WS + 5'  
PLAN AND PROFILE  
STA. 530+00 TO STA. 558+00

SHEET NO. <b>C-121</b>
24 OF 39
SEQUENCE NO. <b>39</b>



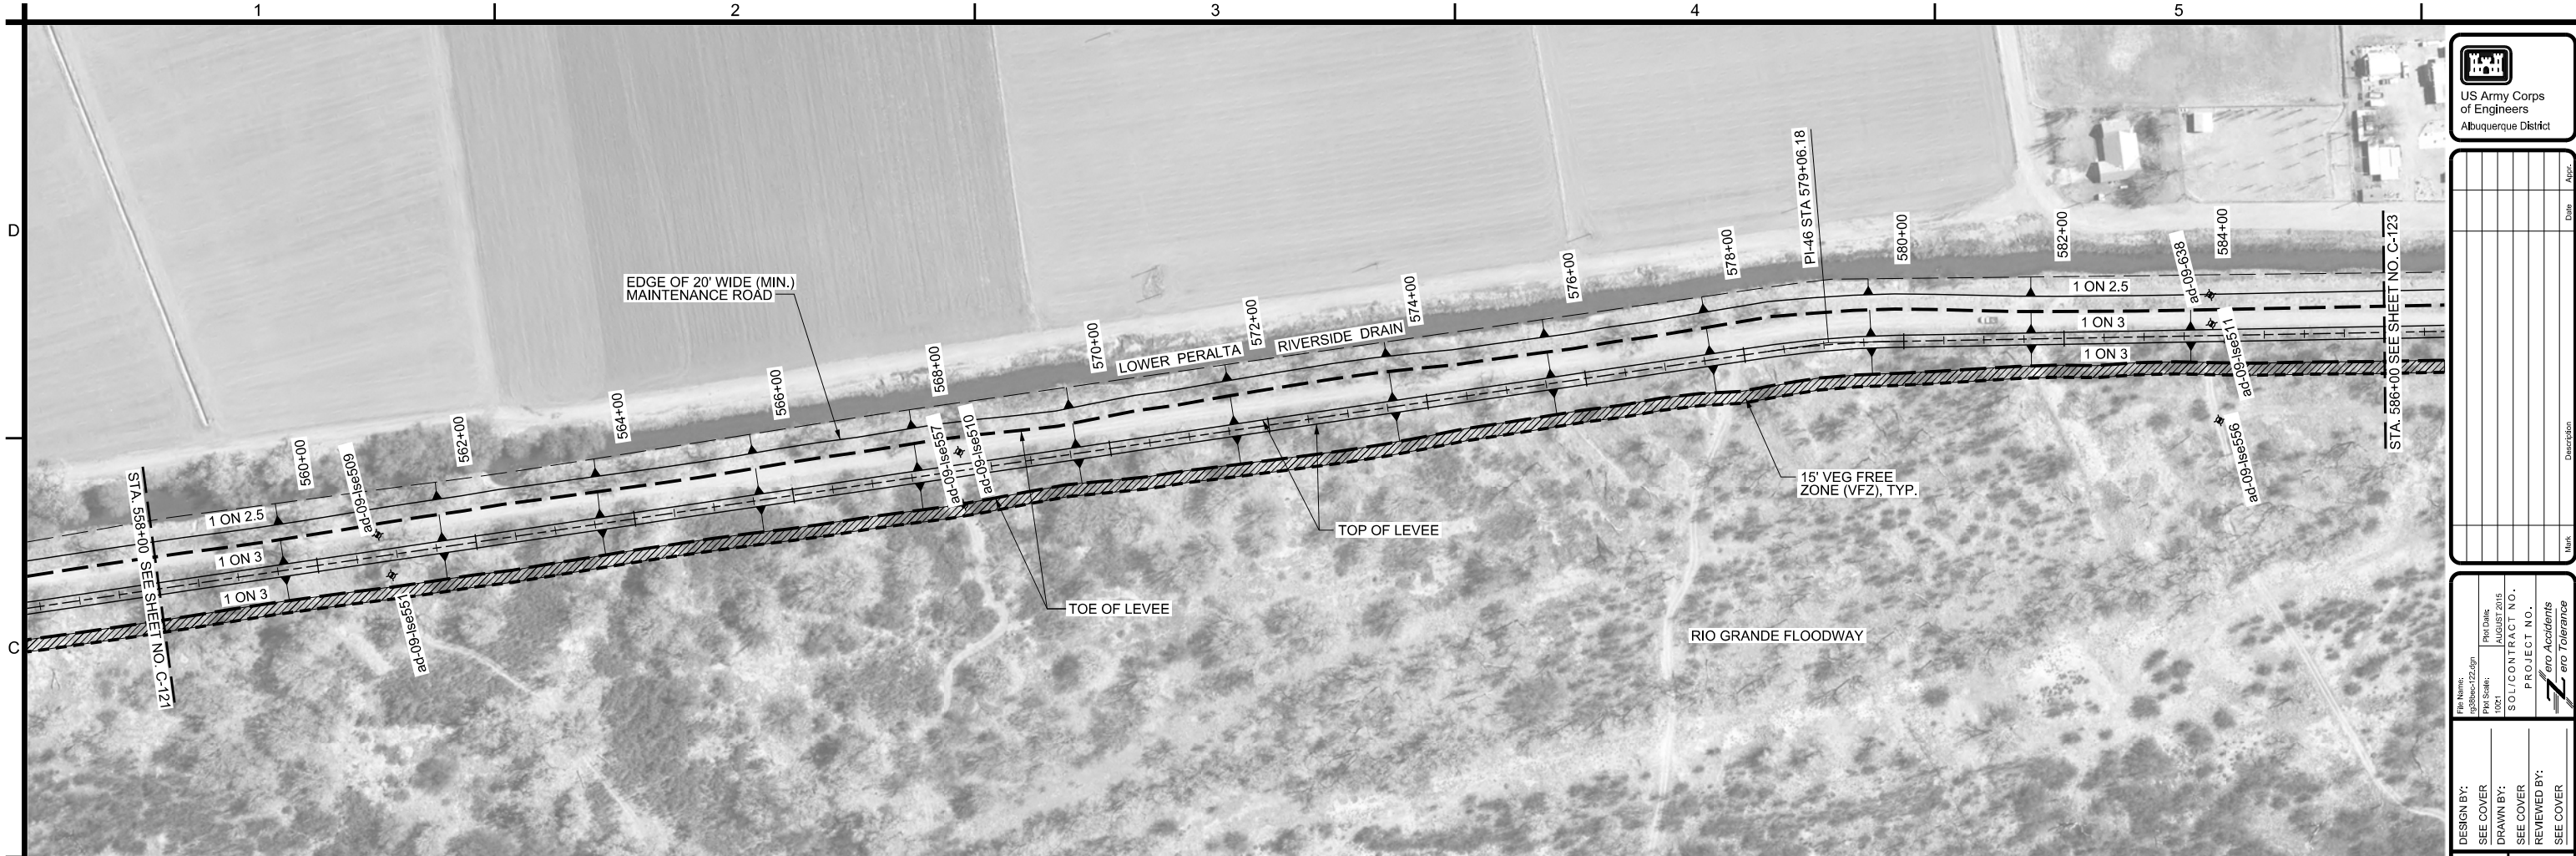


**PLAN**  
SCALE: 1" = 100'

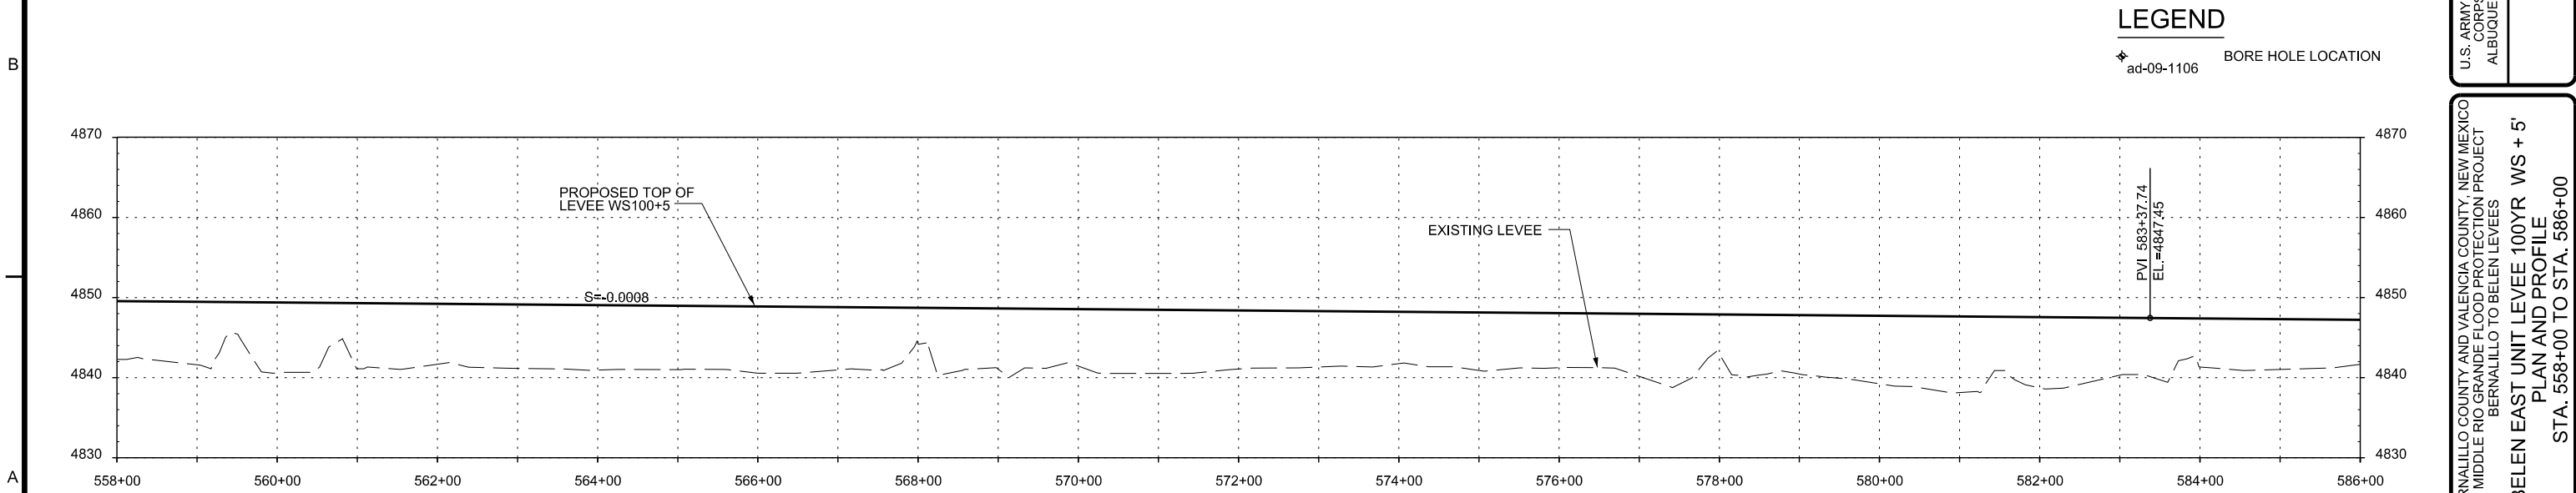

**PROFILE**  
SCALE: HORIZ: 1" = 100'  
VERT: 1"=10'

**LEGEND**  
ad-09-1106 BORE HOLE LOCATION

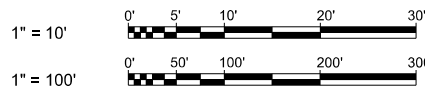

US Army Corps of Engineers  
Albuquerque District

Mark	Description	Date	Appr.

File Name: c:\bureau\22.dgn  
Plot Scale: 100:1  
Plot Date: AUGUST 2015  
SOL/CONTRACT NO.:  
PROJECT NO.:  
ero Accidents  
ero Tolerance

DESIGN BY:  
SEE COVER  
DRAWN BY:  
SEE COVER  
REVIEWED BY:  
SEE COVER

U.S. ARMY ENGINEER DISTRICT  
CORPS OF ENGINEERS  
ALBUQUERQUE, NEW MEXICO

BERNALILLO COUNTY AND VALENCIA COUNTY, NEW MEXICO  
MIDDLE RIO GRANDE FLOOD PROTECTION PROJECT  
BERNALILLO TO BELEN LEVEES  
BELEN EAST UNIT LEVEE 100YR WS + 5'  
PLAN AND PROFILE  
STA. 558+00 TO STA. 586+00

SHEET NO.  
**C-122**  
25 OF 46

SEQUENCE NO.  
**40**





















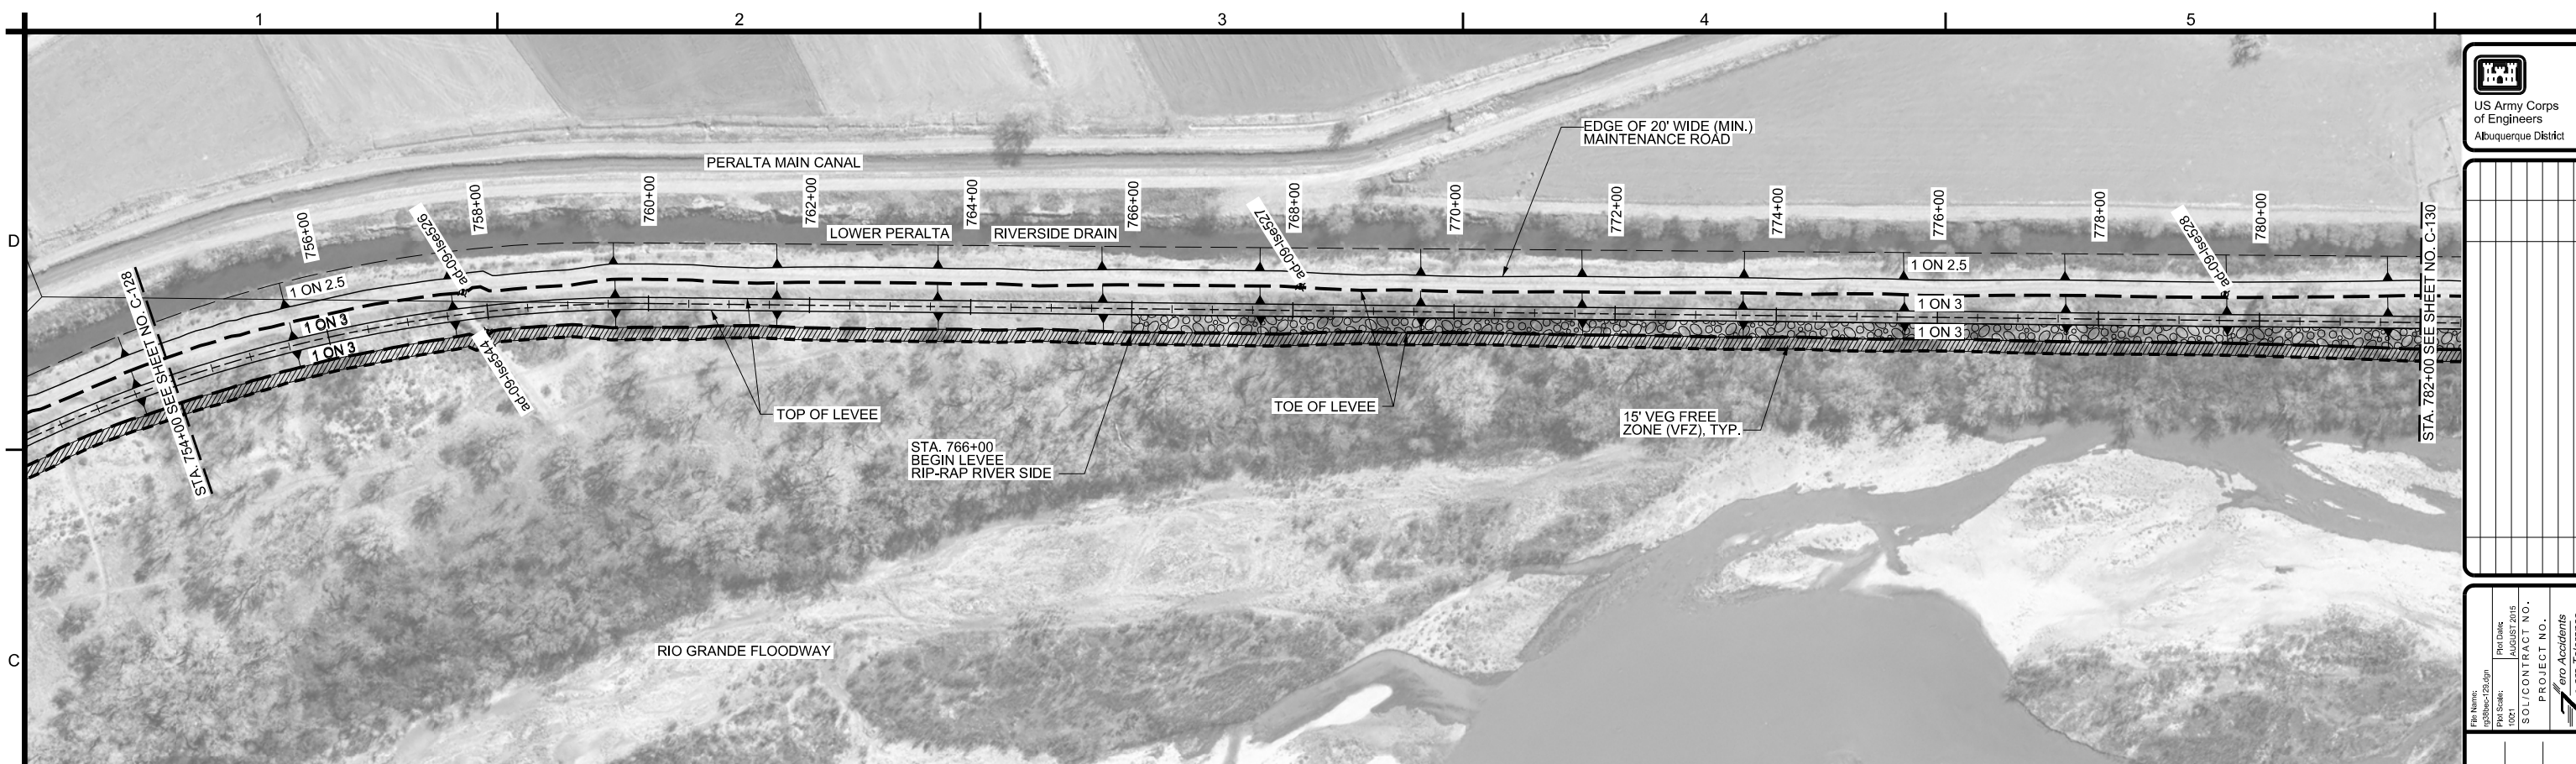


**PLAN**  
SCALE: 1" = 100'

**LEGEND**  
◆ ad-09-1106 BORE HOLE LOCATION

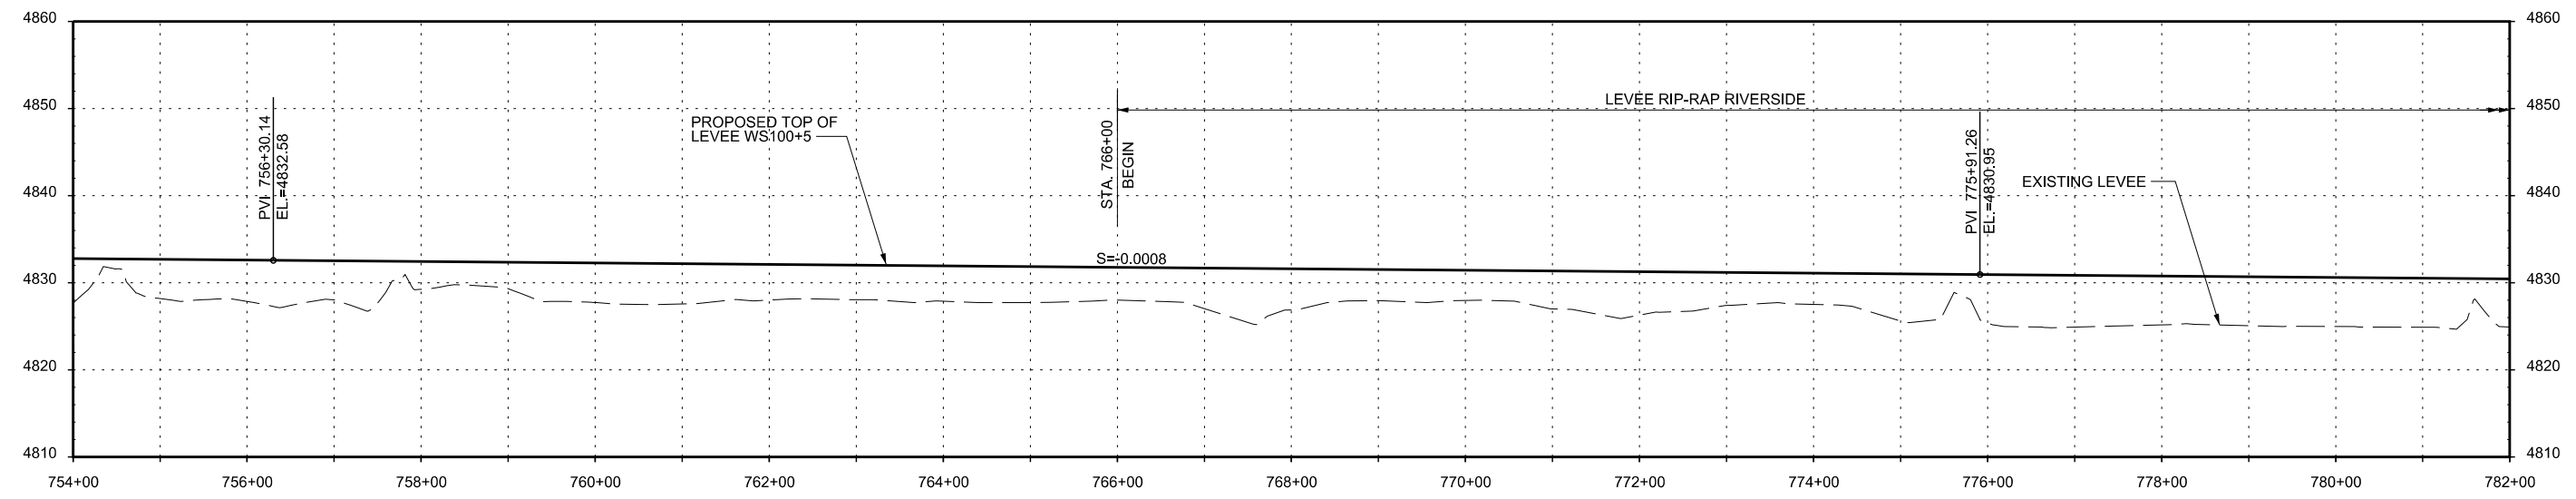

**PROFILE**  
SCALE: HORIZ: 1" = 100'  
VERT: 1"=10'

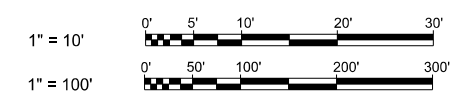

US Army Corps  
of Engineers  
Albuquerque District

Mark	Description	Date	Appr.

File Name: g:\Bentley\2015.dgn  
Plot Scale: 100:1  
Plot Date: AUGUST 2015  
SOL/CONTRACT NO.:  
PROJECT NO.:  
ero Accidents  
ero Tolerance

DESIGN BY:  
SEE COVER  
DRAWN BY:  
SEE COVER  
REVIEWED BY:  
SEE COVER


U.S. ARMY ENGINEER DISTRICT  
CORPS OF ENGINEERS  
ALBUQUERQUE, NEW MEXICO

BERNALILLO COUNTY AND VALENCIA COUNTY, NEW MEXICO  
MIDDLE RIO GRANDE FLOOD PROTECTION PROJECT  
BERNALILLO TO BELEN LEVEES  
BELEN EAST UNIT LEVEE 100YR WS + 5'  
PLAN AND PROFILE  
STA. 754+00 TO STA. 782+00

SHEET NO.  
**C-129**  
32 OF 39


SEQUENCE NO.  
**47**



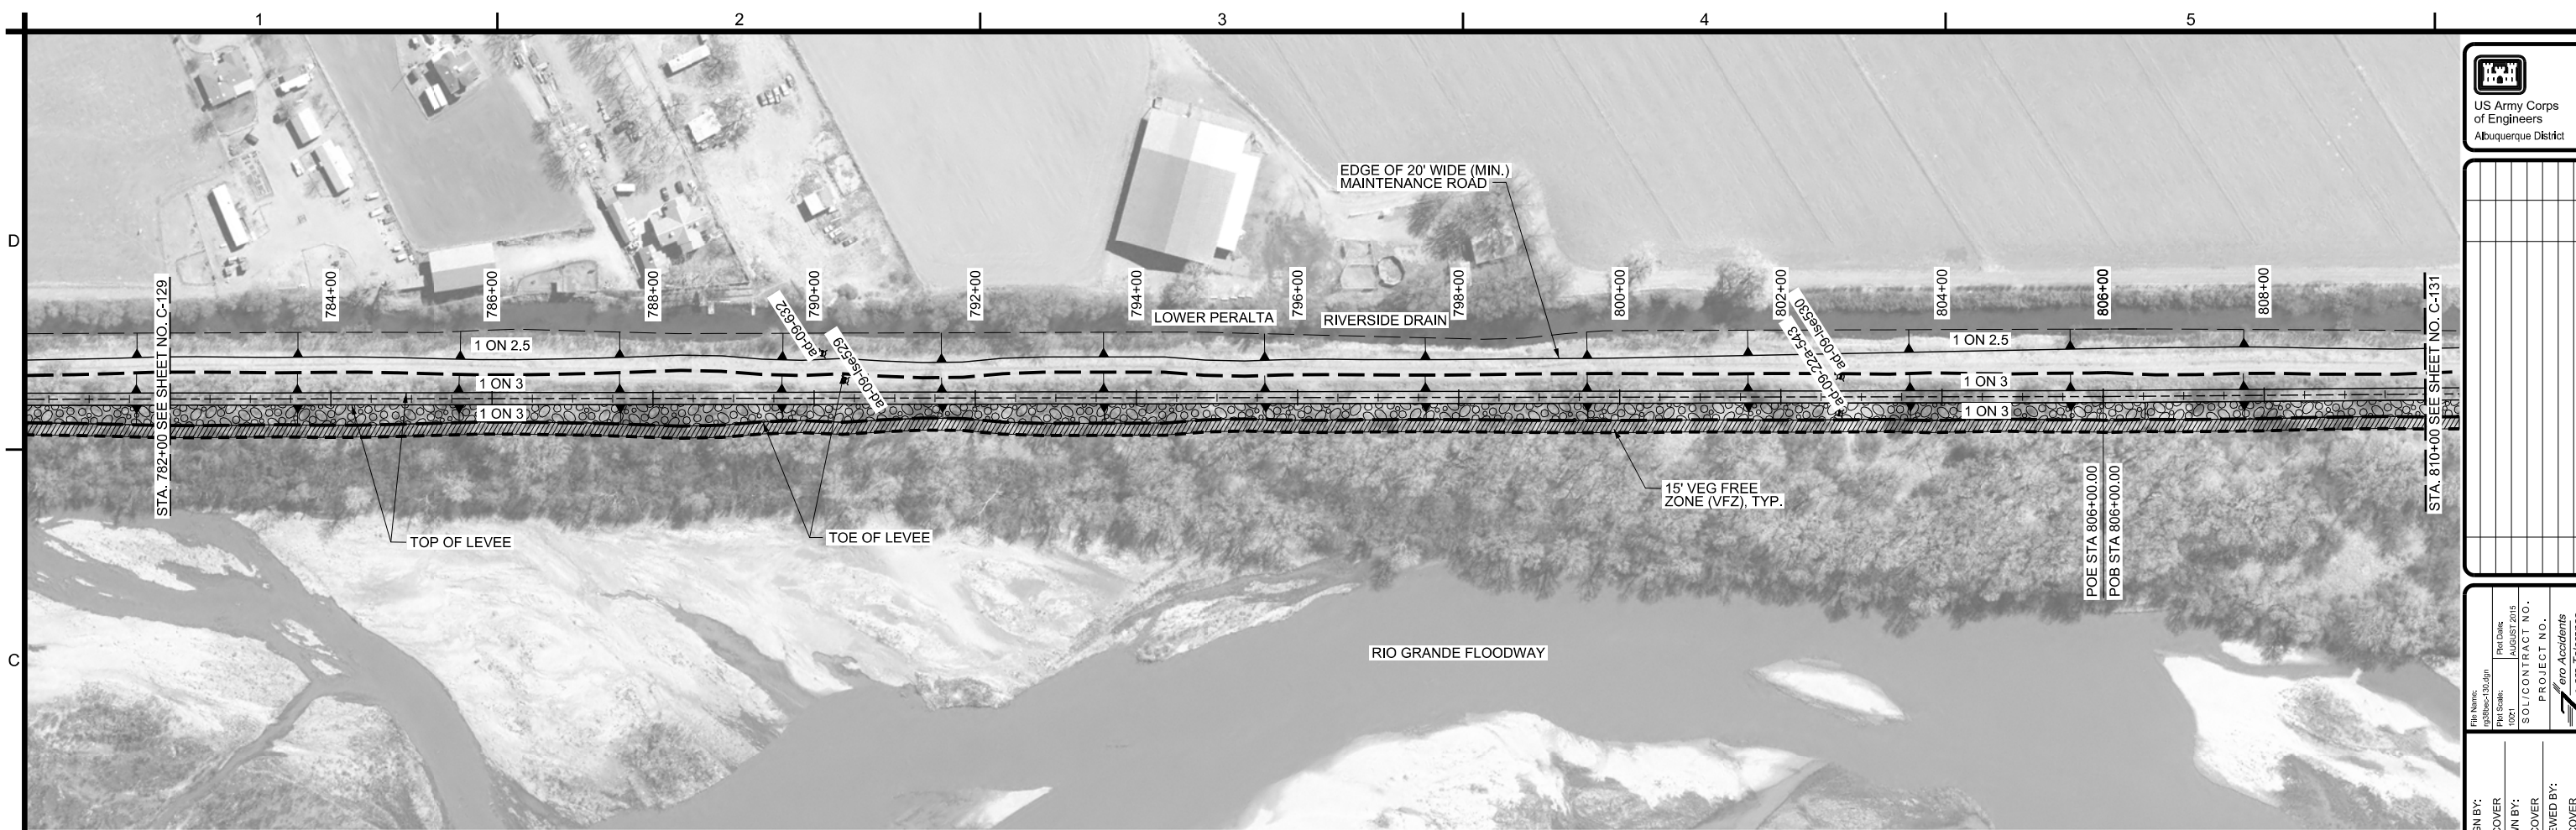


**PLAN**  
SCALE: 1" = 100'

**LEGEND**  
◆ ad-09-1106 BORE HOLE LOCATION

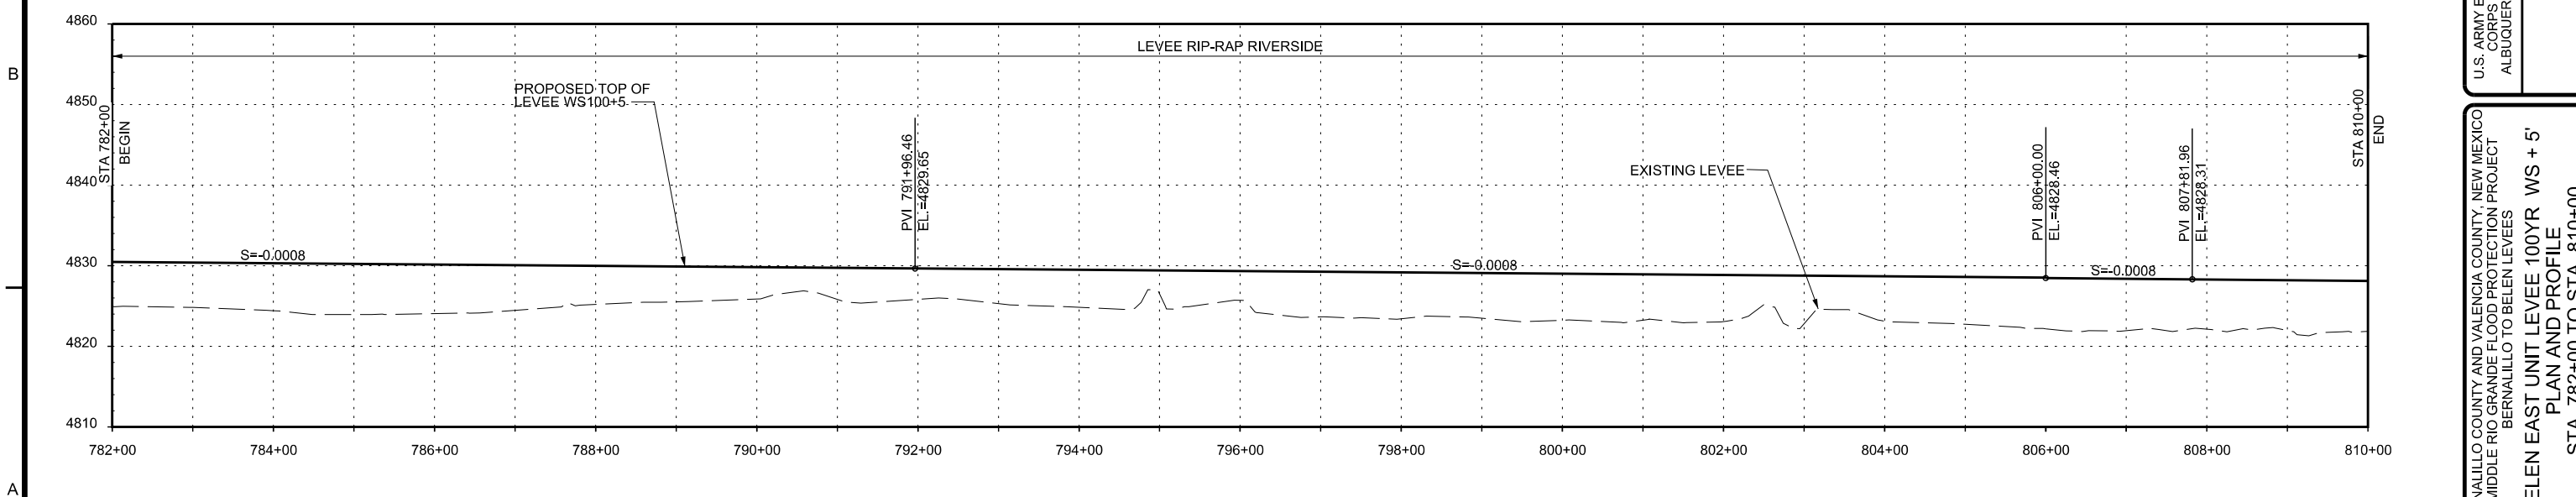

**PROFILE**  
SCALE: HORIZ: 1" = 100'  
VERT: 1"=10'

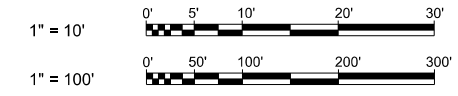

US Army Corps  
of Engineers  
Albuquerque District

Mark	Description	Date	Appr.

File Name: g:\Bentley\30.dgn  
Plot Scale: 100:1  
Plot Date: AUGUST 2015  
SOL/CONTRACT NO.:  
PROJECT NO.:  
ero Accidents  
ero Tolerance

DESIGN BY:  
SEE COVER  
DRAWN BY:  
SEE COVER  
REVIEWED BY:  
SEE COVER

U.S. ARMY ENGINEER DISTRICT  
CORPS OF ENGINEERS  
ALBUQUERQUE, NEW MEXICO

BERNALILLO COUNTY AND VALENCIA COUNTY, NEW MEXICO  
MIDDLE RIO GRANDE FLOOD PROTECTION PROJECT  
BERNALILLO TO BELEN LEVEES  
BELEN EAST UNIT LEVEE 100YR WS + 5'  
PLAN AND PROFILE  
STA. 782+00 TO STA. 810+00

SHEET NO.  
**C-130**  
33 OF 39


SEQUENCE NO.  
**48**



**PLAN**  
SCALE: 1" = 100'

**LEGEND**

ad-09-1106 BORE HOLE LOCATION

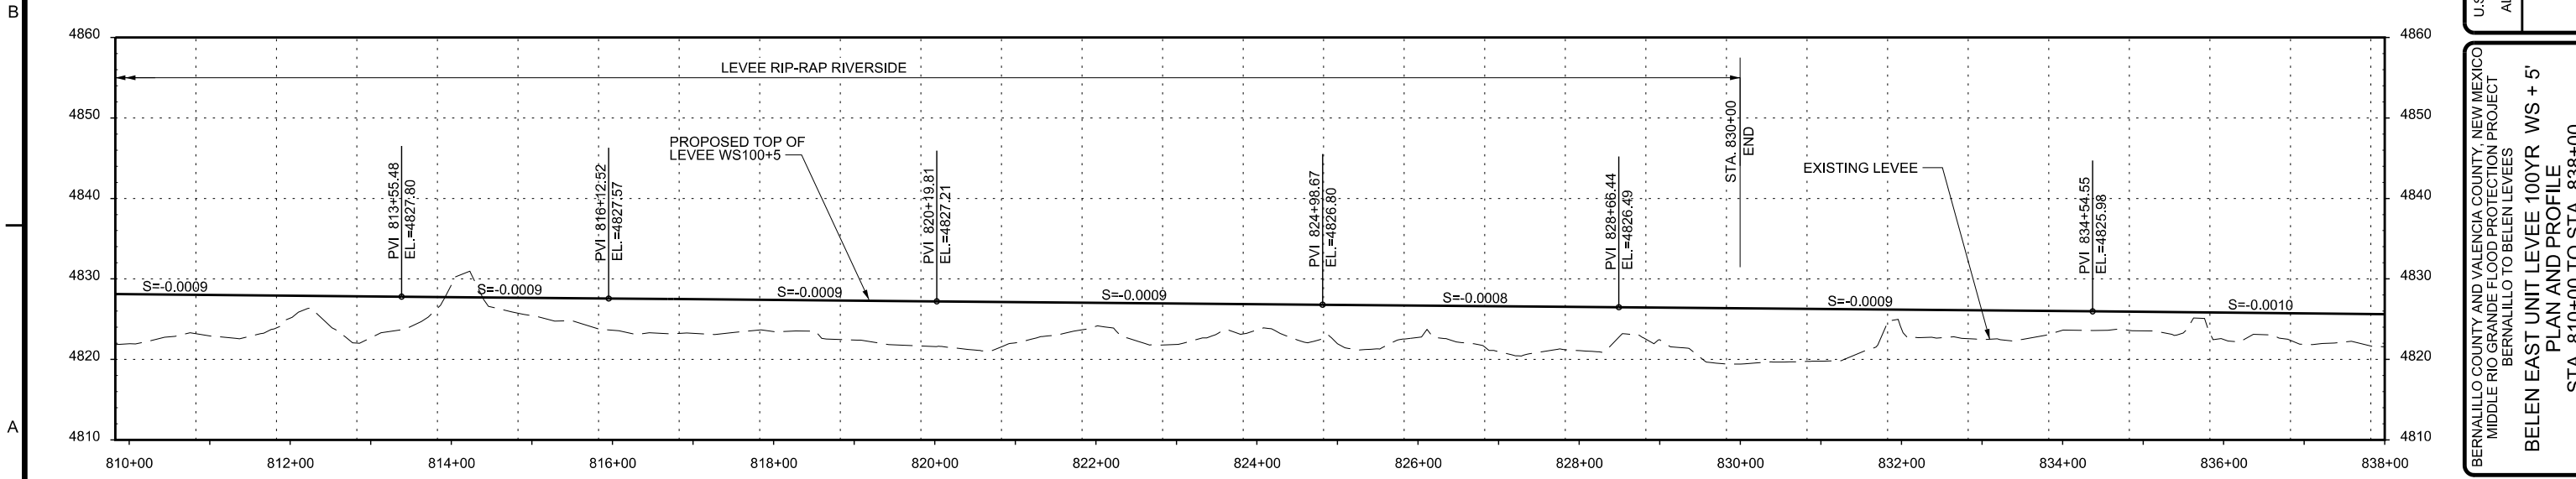

**PROFILE**  
SCALE: HORIZ: 1" = 100'  
VERT: 1"=10'

1" = 10'  
1" = 100'

0' 5' 10' 20' 30'  
0' 50' 100' 200' 300'

US Army Corps  
of Engineers  
Albuquerque District

Mark	Description	Date	Appr.

File Name: c:\bureau\31.dgn  
Plot Scale: 100:1  
Plot Date: AUGUST 2015

SOL/CONTRACT NO.:  
PROJECT NO.:  
ero Accidents  
ero Tolerance

DESIGN BY:  
SEE COVER

DRAWN BY:  
SEE COVER

REVIEWED BY:  
SEE COVER


U.S. ARMY ENGINEER DISTRICT  
CORPS OF ENGINEERS  
ALBUQUERQUE, NEW MEXICO

BERNALILLO COUNTY AND VALENCIA COUNTY, NEW MEXICO  
MIDDLE RIO GRANDE FLOOD PROTECTION PROJECT  
BERNALILLO TO BELEN LEVEES  
BELEN EAST UNIT LEVEE 100YR WS + 5'  
PLAN AND PROFILE  
STA. 810+00 TO STA. 838+00

SHEET NO.  
**C-131**  
34 OF 39


SEQUENCE NO.  
**49**



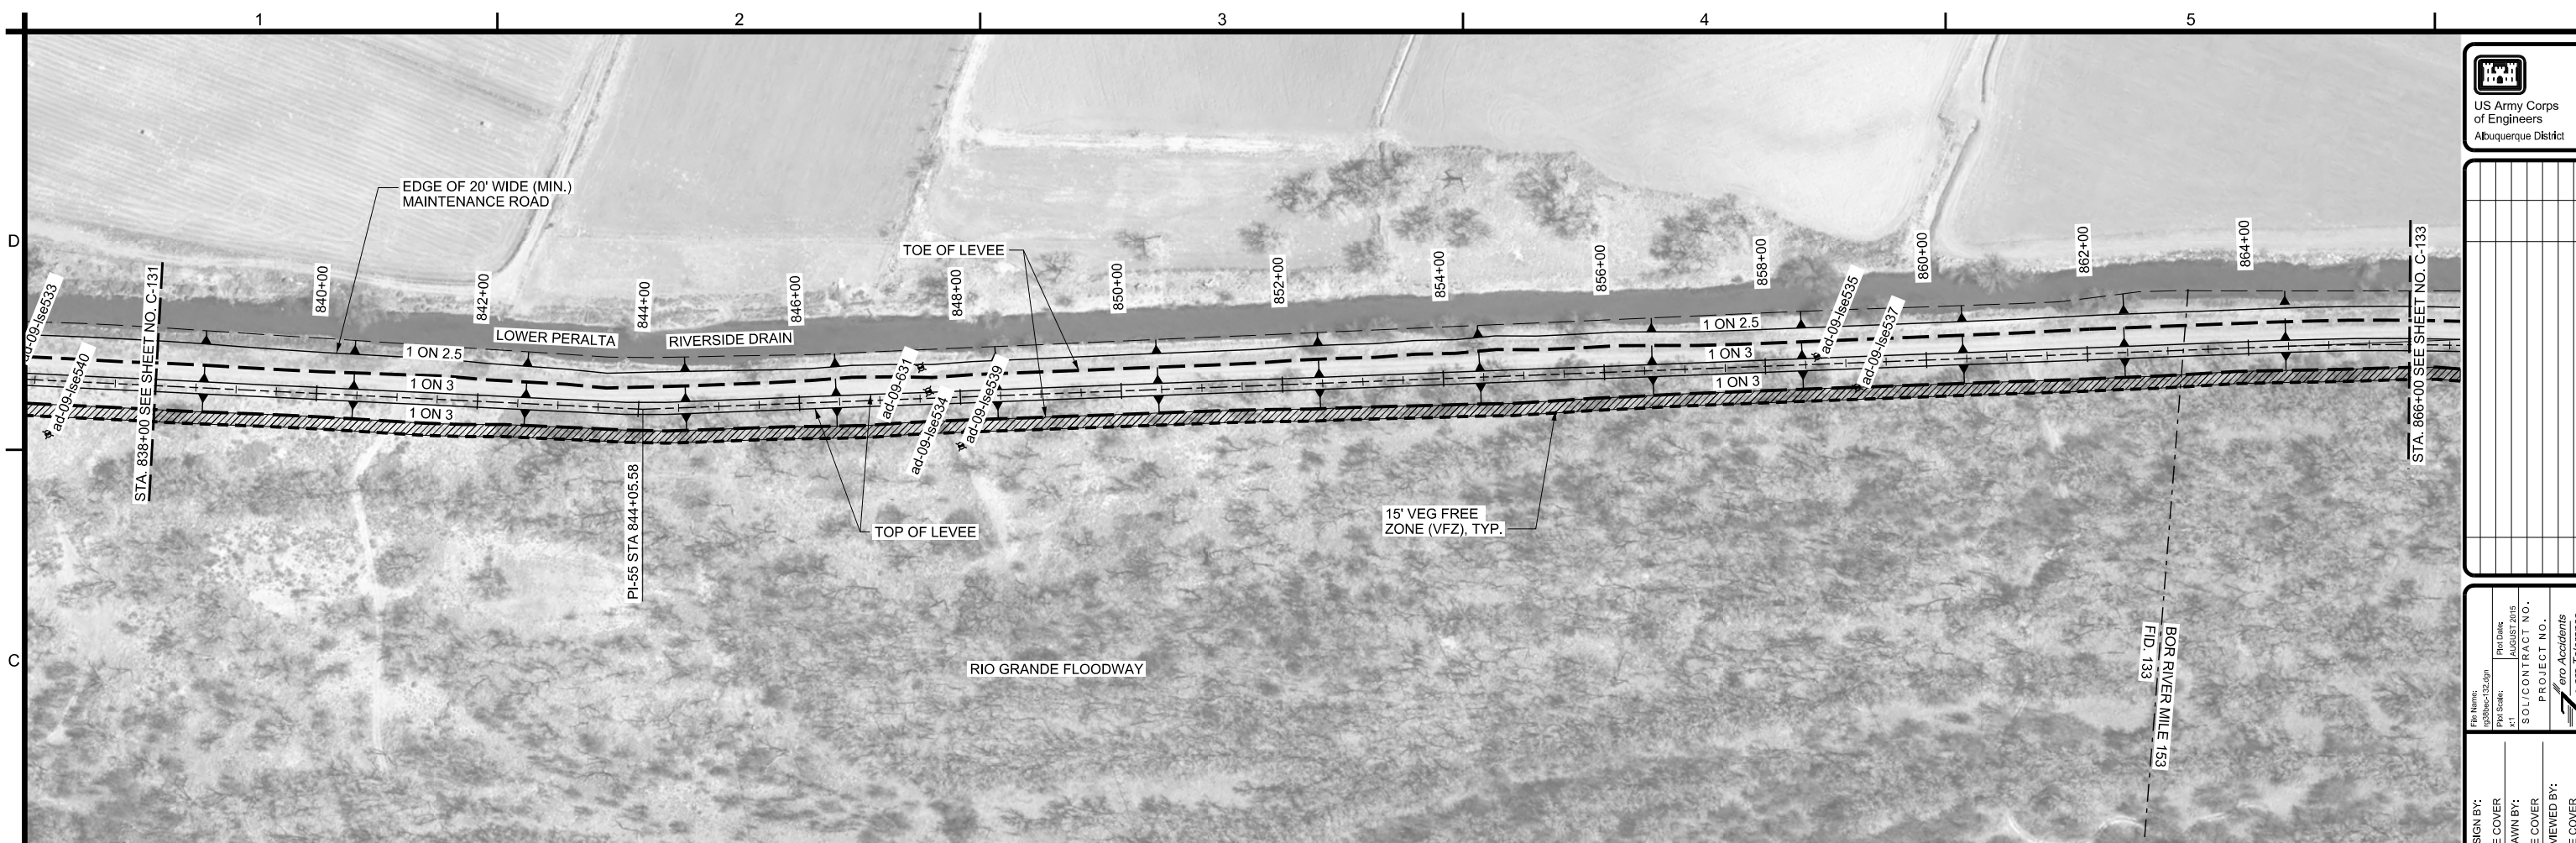


**PLAN**  
SCALE: 1" = 100'

**LEGEND**  
ad-09-1106 BORE HOLE LOCATION

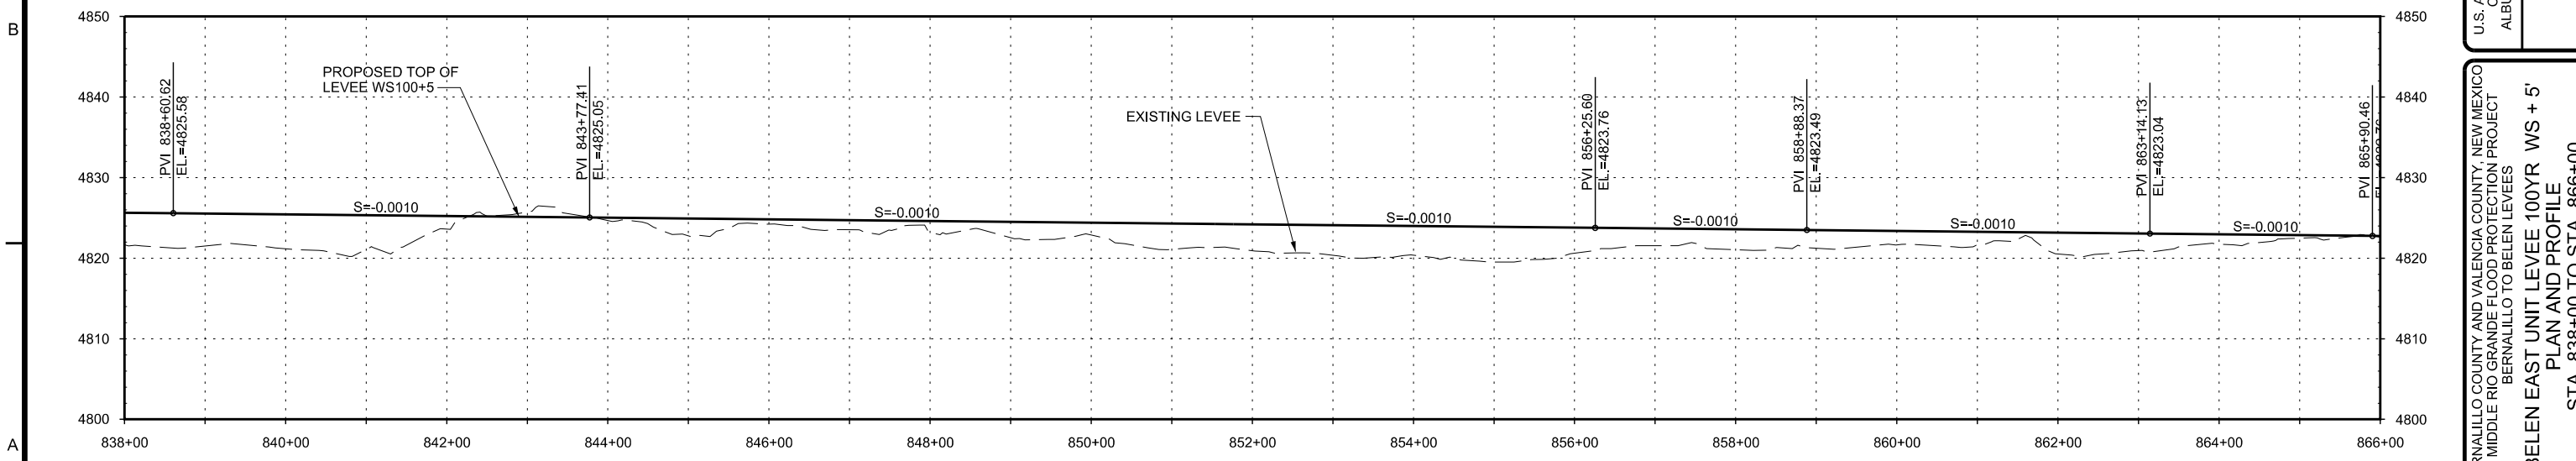

**PROFILE**  
SCALE: HORIZ: 1" = 100'  
VERT: 1"=10'

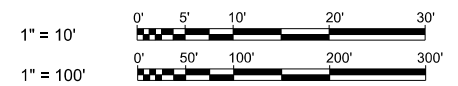

US Army Corps  
of Engineers  
Albuquerque District

Mark	Description	Date	Appr.

File Name: c:\bentley\132.dgn  
Plot Scale: x1  
Plot Date: AUGUST 2015  
SOL/CONTRACT NO.:  
PROJECT NO.:  
Bore Hole Location: ad-09-1106  
Bore Hole Tolerance: 1/2"

DESIGN BY: SEE COVER  
DRAWN BY: SEE COVER  
CHECKED BY: SEE COVER  
REVIEWED BY: SEE COVER

U.S. ARMY ENGINEER DISTRICT  
CORPS OF ENGINEERS  
ALBUQUERQUE, NEW MEXICO

BERNALILLO COUNTY AND VALENCIA COUNTY, NEW MEXICO  
MIDDLE RIO GRANDE FLOOD PROTECTION PROJECT  
BERNALILLO TO BELEN LEVEES  
BELEN EAST UNIT LEVEE 100YR WS + 5'  
PLAN AND PROFILE  
STA. 838+00 TO STA. 866+00



SHEET NO.  
**C-132**  
35 OF 39

SEQUENCE NO.  
**50**








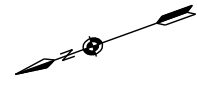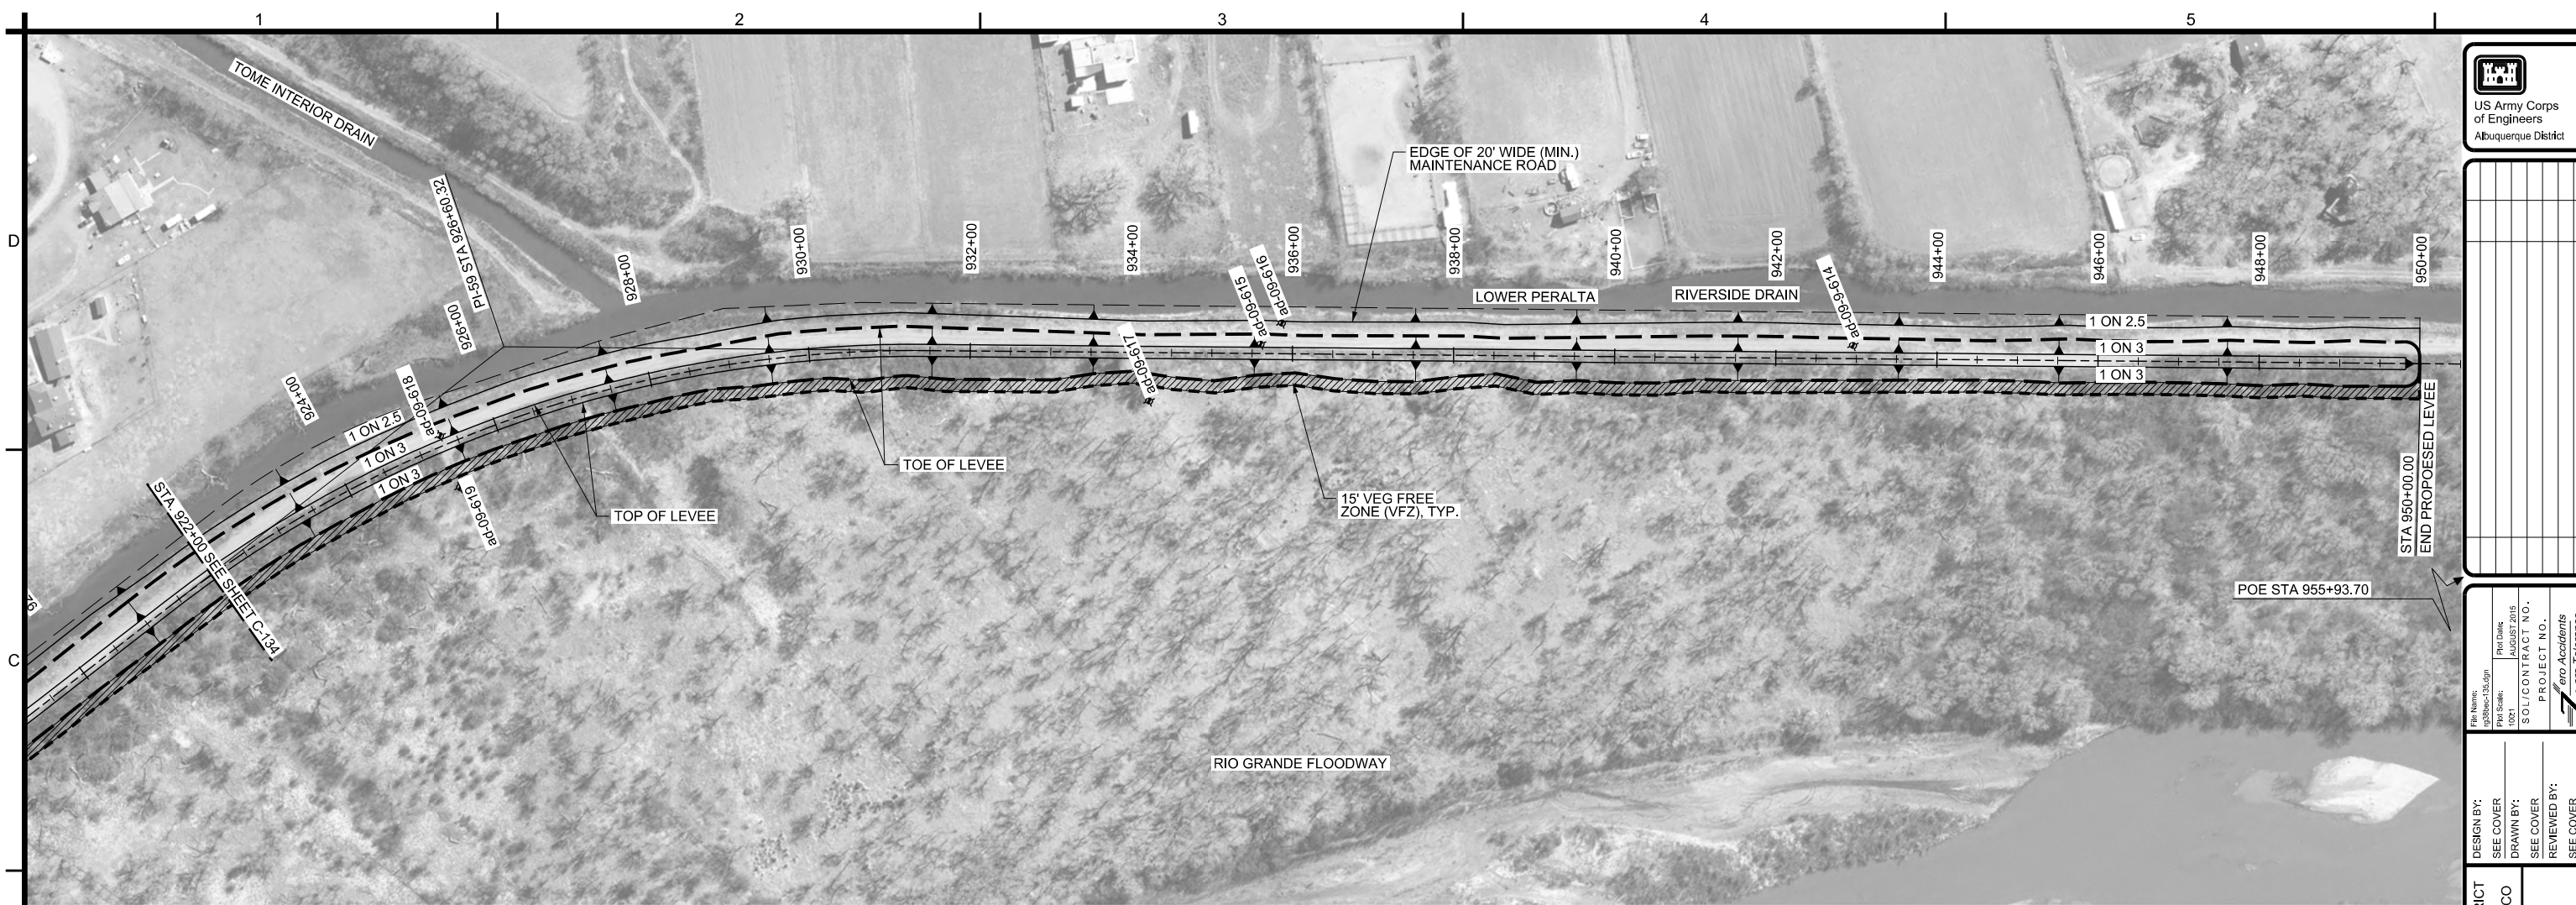


PLAN  
SCALE: 1" = 100'

LEGEND

ad-09-1106 BORE HOLE LOCATION

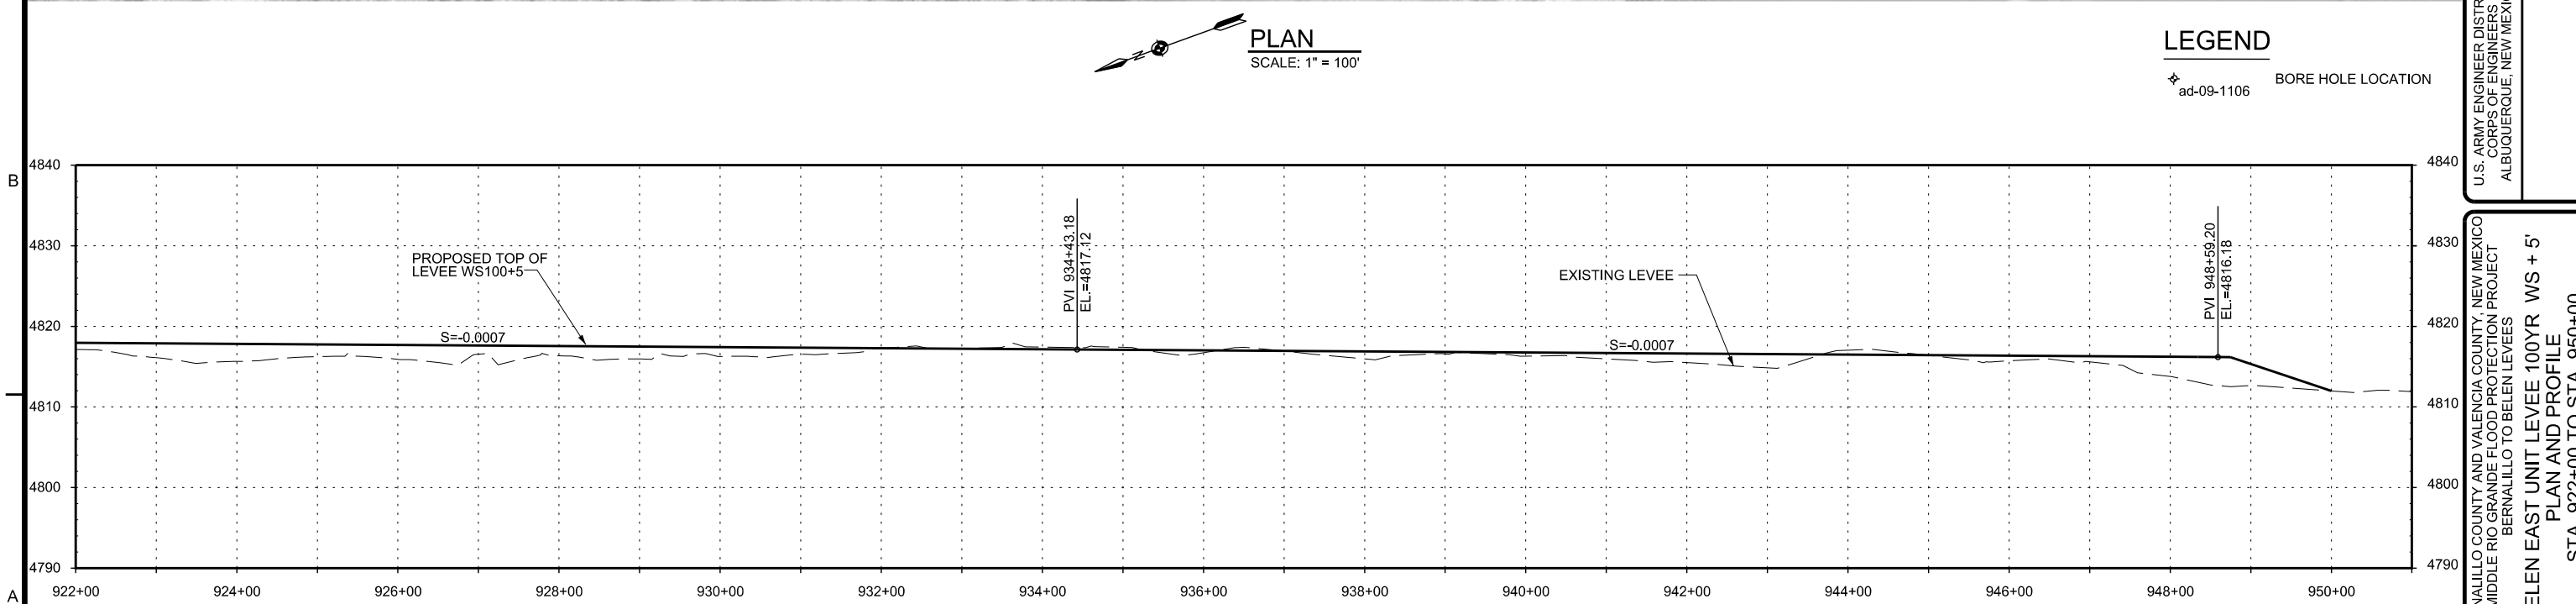

PROFILE  
SCALE: HORIZ: 1" = 100'  
VERT: 1"=100'

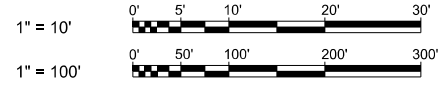

Mark	Description	Date	Appr.

File Name: c:\bentley\135.dgn	Proj Date: AUGUST 2015
Proj Scale: 100:1	SOL/CONTRACT NO.: PROJECT NO.
ero Accidents ero Tolerance	

DESIGN BY: SEE COVER	SEE COVER
DRAWN BY: SEE COVER	SEE COVER
REVIEWED BY: SEE COVER	SEE COVER

U.S. ARMY ENGINEER DISTRICT  
CORPS OF ENGINEERS  
ALBUQUERQUE, NEW MEXICO

BERNALILLO COUNTY AND VALENCIA COUNTY, NEW MEXICO  
MIDDLE RIO GRANDE FLOOD PROTECTION PROJECT  
BERNALILLO TO BELEN LEVEES  
BELEN EAST UNIT LEVEE 100YR WS + 5'  
PLAN AND PROFILE  
STA. 922+00 TO STA. 950+00

SHEET NO.  
**C-135**  
38 OF 39  
SEQUENCE NO.  
**53**



